
CITY OF LA PINE

SIDEWALK AND MULTI-USE PATH IMPROVEMENT PROJECT

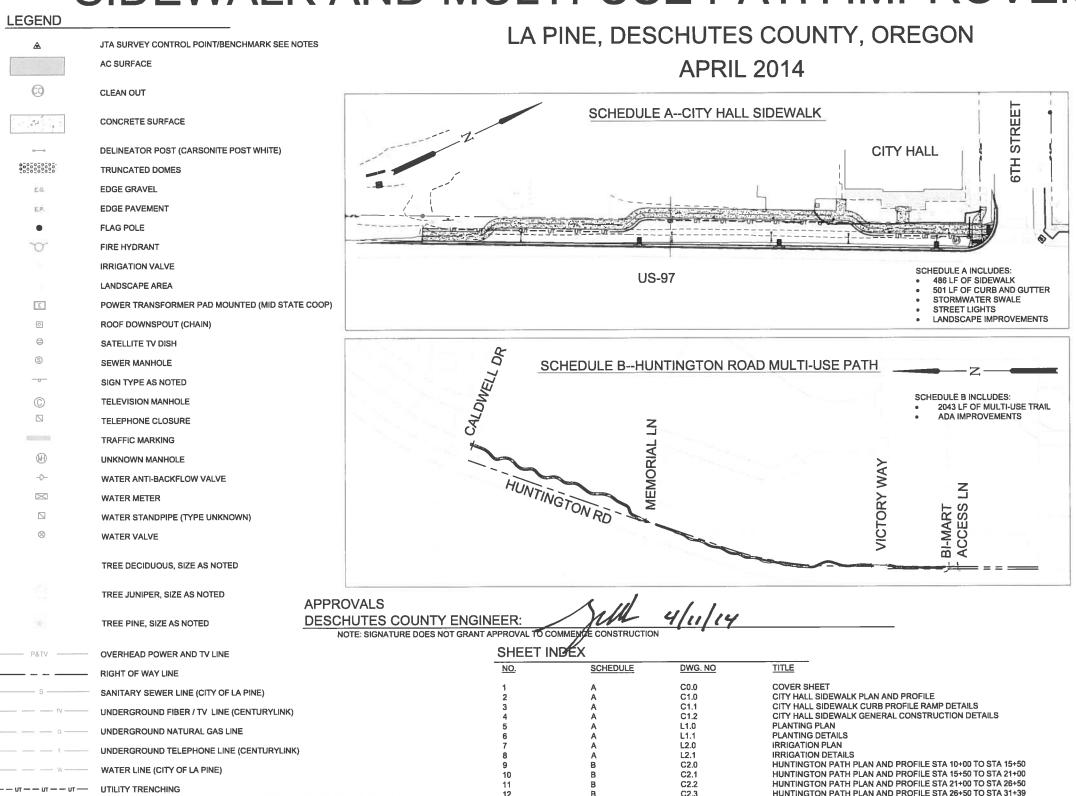

GENERAL NOTES:

- NO CONSTRUCTION SHALL BE STARTED WITHOUT A NOTICE TO PROCEED BY THE CITY PUBLIC
 WORKS DEPARTMENT. THE CITY PUBLIC WORKS DEPARTMENT AND THE DESIGN ENGINEER SHALL BE
 NOTIFIED AT LEAST 24 HOURS PRIOR TO THE START OF CONSTRUCTION. ANY CONSTRUCTION WORK
 DONE PRIOR TO NOTICE TO PROCEED BEING ISSUED OR WITHOUT INSPECTION WILL BE REJECTED.
- 2. CONTRACTOR SHALL VERIFY ALL CONDITIONS ON THE JOB SITE INCLUDING BUT NOT LIMITED TO, ALL DIMENSIONS, GRADES, ELEVATIONS, EXTENT AND COMPATIBILITY TO THE EXISTING SITE CONDITIONS, AND WITH THE WORK DESCRIBED ON THE ENGINEER'S DRAWINGS. ANY DISCREPANCIES OR UNEXPECTED CONDITIONS THAT AFFECT OR CHANGE THE WORK DESCRIBED IN THE CONTRACT DOCUMENTS SHALL BE BROUGHT TO THE ENGINEER'S ATTENTION IMMEDIATELY. CONTRACTOR SHALL NOT PROCEED WITH ANY OF THE WORK IN THE AREA OF DISCREPANCIES UNTIL ALL SUCH DISCREPANCIES ARE RESOLVED. IF THE CONTRACTOR CHOOSES TO DO SO, THEN IT IS UNDERSTOOD THAT THE CONTRACTOR IS CHOOSING TO PROCEED AT THE CONTRACTOR'S OWN RISK AND SHALL INCUR ALL COSTS, IF ANY TO RESOLVE THE ISSUES TO THE SATISFACTION OF THE ENGINEER.
- A CITY INSPECTOR ACTING ON BEHALF OF THE CITY MAY REQUIRE REVISIONS IN PLANS TO SOLVE UNFORESEEN PROBLEMS THAT MAY ARISE IN THE FIELD.
- ALL CONSTRUCTION WORK AND INSTALLATIONS SHALL CONFORM TO THE 2008 OREGON STANDARD SPECIFICATIONS FOR CONSTRUCTION, AND ALL WORK SHALL BE SUBJECT TO THE APPROVAL OF THE CITY
- 5. IT SHALL BE THE RESPONSIBILITY OF THE CONTRACTOR TO CONTACT "UNDERGROUND LOCATE SERVICE" AT 1-800-332-2344 AT LEAST 48 BUSINESS-DAY HOURS PRIOR TO THE START OF CONSTRUCTION FOR THE LOCATION OF POWER, GAS, CABLE TV AND TELEPHONE UNDERGROUND FACILITIES. THE CONTRACTOR WILL ALSO BE RESPONSIBLE FOR CONTACTING THE APPROPRIATE PUBLIC AGENCY FOR THE LOCATION OF UNDERGROUND FACILITIES.
- 6. ALL UTILITIES SHOWN ARE ACCURATE TO THE EXTENT OF AVAILABLE RECORDS AND KNOWLEDGE. NO POTHOLING TO VERIFY LOCATIONS AND ELEVATIONS WAS AUTHORIZED BY THE OWNER. THE CONTRACTOR HAS THE TOTAL RESPONSIBILITY TO VERIFY THE LOCATION OF EXISTING UNDERGROUND UTILITIES AND TO NOTIFY THE UTILITY COMPANIES WHEN WORKING IN THEIR PROXIMITY. CONTRACTOR TO VERIFY LOCATION OF EXISTING UTILITIES PRIOR TO CONSTRUCTION. OREGON LAW REQUIRES YOU TO FOLLOW RULES ADOPTED BY THE OREGON UTILITY NOTIFICATION CENTER. THOSE RULES ARE SET FORTH IN OAR 952-001-0010 THROUGH 952-001-0090. YOU MAY OBTAIN COPIES OF THE RULES BY CALLING THE CENTER. THE TELEPHONE NUMBER FOR THE OREGON UTILITY NOTIFICATION CENTER IS (503)232-2987.
- ALL FINAL CUT SLOPES SHALL NOT EXCEED A GRADE OF 2 HORIZONTAL TO 1 VERTICAL UNLESS
 OTHERWISE APPROVED. FILL SLOPES SHALL NOT EXCEED A GRADE OF 2 HORIZONTAL TO 1 VERTICAL
 UNLESS OTHERWISE APPROVED BY THE ENGINEER.
- 8. ALL UNSUITABLE SOILS MATERIALS, RUBBISH AND DEBRIS RESULTING FROM GRADING OPERATIONS SHALL BE REMOVED FROM THE JOB SITE AND DISPOSED OF PROPERLY.
- 9. THE CONTRACTOR SHALL EMPLOY ALL LABOR, EQUIPMENT, AND METHODS REQUIRED TO PREVENT DUST IN AMOUNTS DAMAGING TO PROPERTY, CULTIVATED VEGETATION AND DOMESTIC ANIMALS OR CAUSING A NUISANCE TO PERSONS OCCUPYING BUILDINGS IN THE VICINITY OF THE JOB SITE. THE CONTRACTOR SHALL BE RESPONSIBLE FOR ANY DAMAGE CAUSED BY DUST RESULTING FROM CONSTRUCTION.
- 10. THE CONTRACTOR SHALL FOLLOW ALL APPLICABLE INDUSTRIAL SAFETY REGULATIONS. THE CITY AND DESCHUTES COUNTY AND THEIR OFFICIALS, THE ENGINEER, AND THE OWNER SHALL NOT BE RESPONSIBLE FOR ENFORCING SAFETY REGULATIONS.
- 11. MATERIAL QUANTITIES USED, NOTED, OR PROVIDED IN A SEPARATE ITEMIZED QUANTITY TAKE-OFF ARE AN ENGINEER'S OPINION OF PROBABLE MATERIAL REQUIREMENTS, AND IS AN ESTIMATE ONLY. CONTRACTOR'S HAVE THE SOLE RESPONSIBILITY OF MAKING THEIR OWN QUANTITY TAKE-OFF AND COST ESTIMATE.
- 12. ALL WORK SHALL BE PERFORMED BY A CITY APPROVED CONTRACTOR.


COMPLIANCE WITH ACCESSIBILITY GUIDELINES:


ALL IMPROVEMENTS SHALL COMPLY WITH APPLICABLE ACCESSIBILITY GUIDELINES.


APPLICABLE GUIDELINES FOR THIS PROJECT ARE THE UNITED STATES ACCESS BOARD PROPOSED ACCESSIBILITY GUIDELINES FOR PEDESTRIAN FACILITIES IN THE PUBLIC RIGHT OF WAY, JULY 26, 2011

ANY CONSTRUCTION NOT IN CONFORMANCE WITH THESE PLANS AND NOT IN COMPLIANCE WITH APPLICABLE GUIDELINES MUST BE CORRECTED BY THE CONTRACTOR AT THE CONTRACTOR'S EXPENSE.

15 B. GLA HIGH MINOR AND									
NO. DATE BY APPR REVISIONS	VERIFY SCALES BAR IS ONE INCH ON ORIGINAL DRAWING.	POT			NTURY		BEND OFFICE 1020 SW EMKAY DRIVE #100 BEND, OR 97702 541.322.8962 541.382.2423 (FAX)	CITY OF LA PINE SIDEWALK AND MULTI-USE PATH IMPROVEMENT PROJECTS	C0.0
	0" 1" IF NOT ONE INCH ON THIS SHEET, ADJUST SCALES ACCORDINGLY.	EXPIRES: 12/31/P	LA PINE	DESIGNED BY: TH3 DATE: APRIL 2	DRAWN BY: GJR	CHECKED BY: JML PROJECT NO:	SCALE: AS SHOWN 454.001.01	COVER SHEET	SHEET NO.

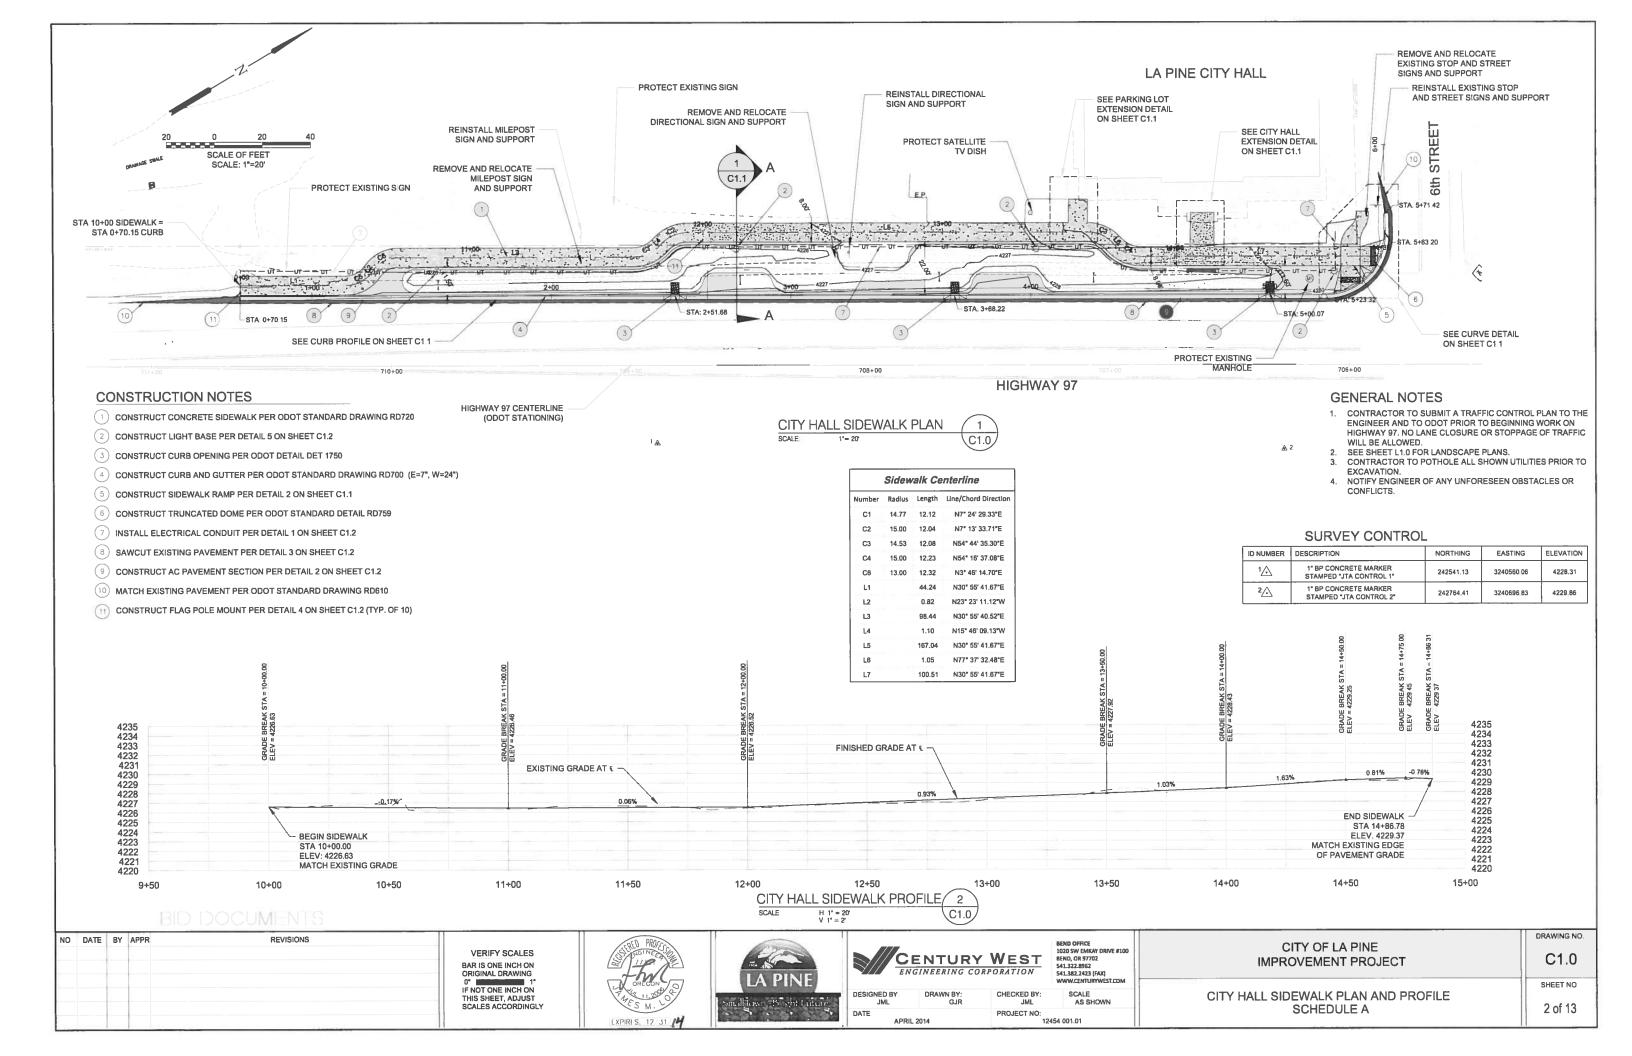

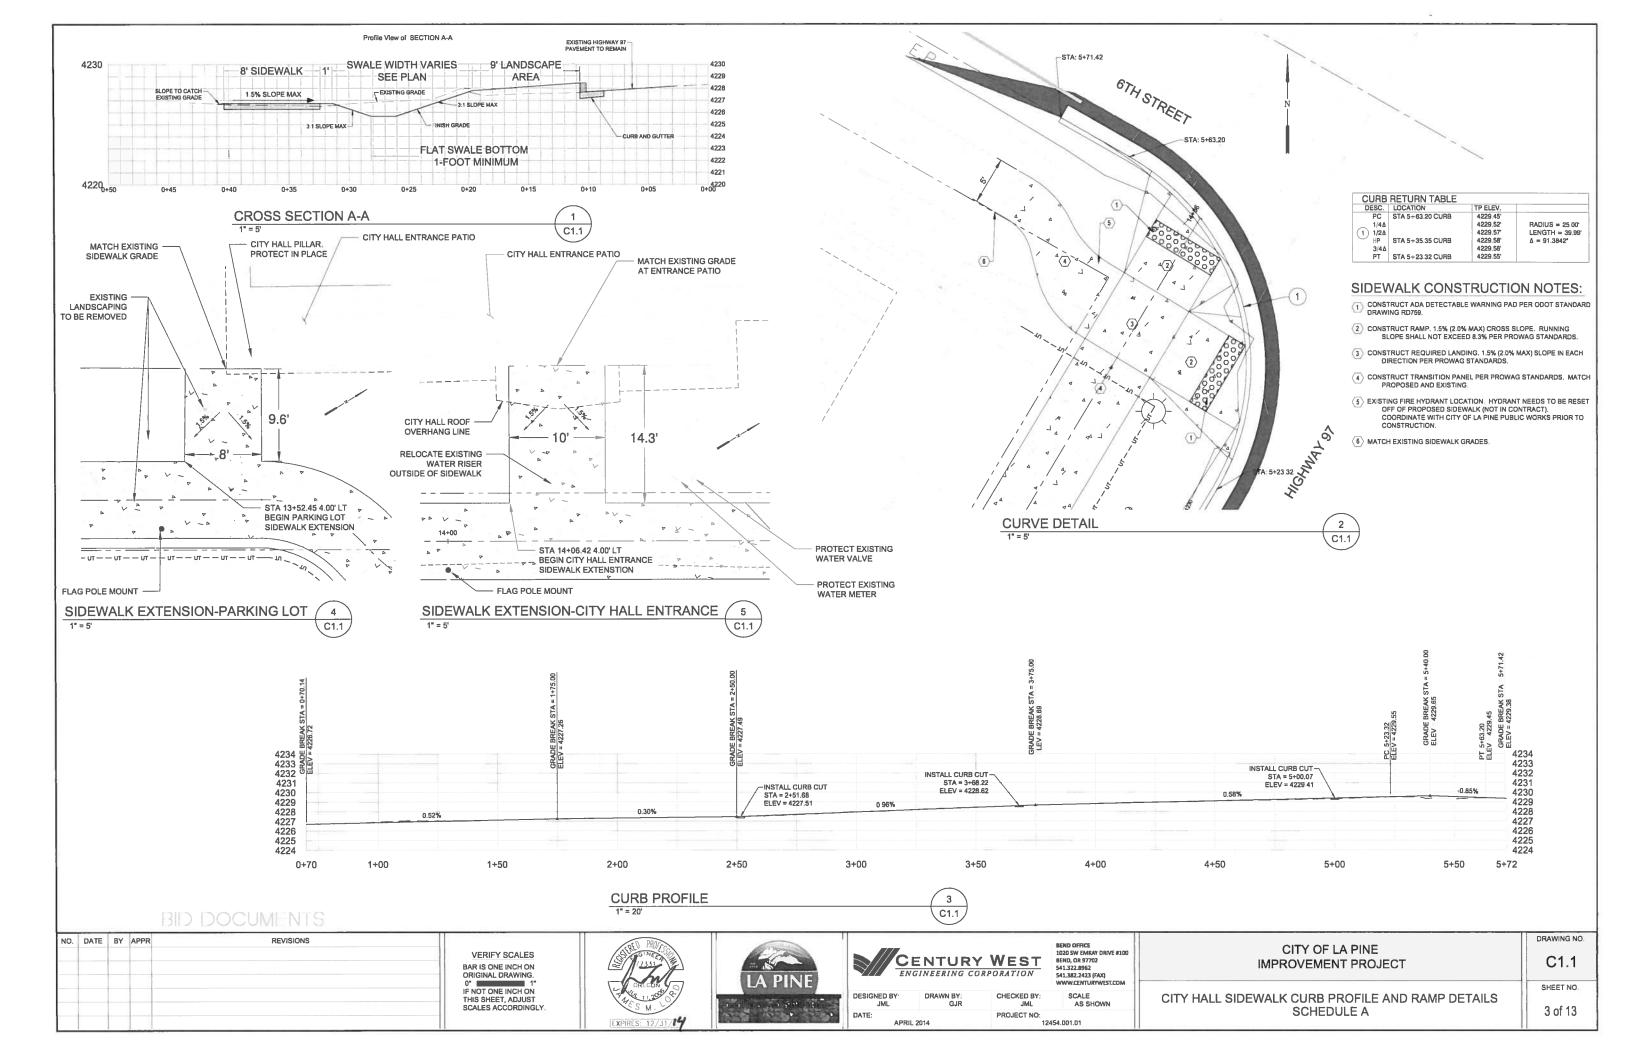

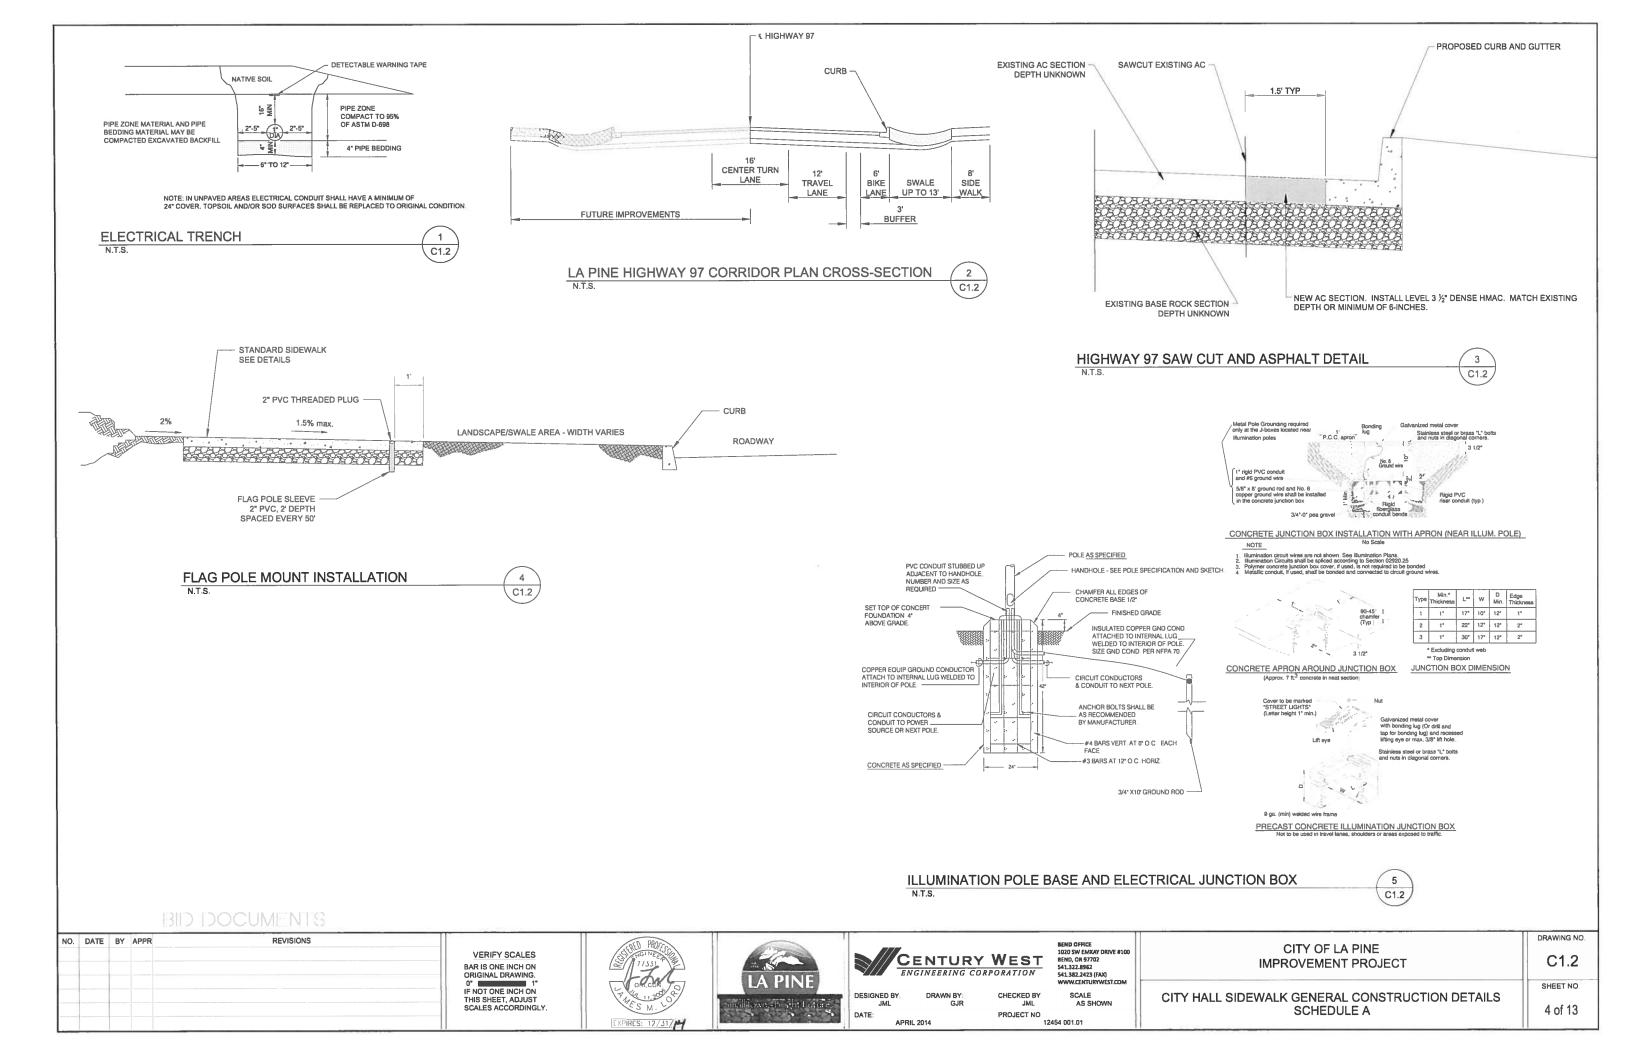





PLANT LEGEND

SYM TREES:	BOTANICAL NAME	COMMON NAME	SIZE	QTY.
6	ACER x FREEMANII 'SIENNA'	SIENNA GLEN MAPLE	3. 5° CAL	8
\bigcirc	EXISTING VEGETATION	PRESERVE AND PROTECT IN PLACE	E	-
PERENNIALS/ GR	ROUNDCOVERS/GRASSES:			
(1)	ARCHTOSTAPHYLOS UVA-URSI	KINNICKINICK	1 GAL	58
0	BRUNNERA M. 'JACK FROST'	JACK FROST BRUNNERA	I GAL	41
\odot	CERASTIUM TOMENTOSUM	SNOW IN SUMMER	I GAL	52
\odot	RHUS AROMATICA	GRO-LOW SUMAC	2 GAL	43
э	VERONICA S. 'RED FOX'	RED FOX SPIKE SPEEDWELL	1 GAL	55
MISC.:				
	TURF	SOD		4515 si

PLANTING NOTES

- 1. SEE CIVIL ENGINEER'S PLANS FOR EXISTING TREES TO BE REMOVED, IF ANY.
- 2. REFER TO CIVIL ENGINEER'S UTILITY AND GRADING PLANS FOR UTILITY LOCATIONS AND FINAL GRADING. IF ACTUAL SITE CONDITIONS VARY FROM WHAT IS SHOWN ON THE LANDSCAPE ARCHITECT'S PLANS, THE CONTRACTOR SHALL CONTACT THE AUTHORIZED REPRESENTATIVE FOR DIRECTION ON HOW TO PROCEED.
- 3. VERIFY LOCATIONS OF ALL PERTINENT SITE IMPROVEMENTS INSTALLED UNDER OTHER SECTIONS. IF ANY PART OF THIS PLAN CANNOT BE FOLLOWED DUE TO SITE CONDITIONS, CONTACT THE OWNER'S AUTHORIZED REPRESENTATIVE FOR INSTRUCTION PRIOR TO COMMENCING WORK.
- 4. EXACT LOCATIONS OF PLANT MATERIALS SHALL BE REVIEWED BY THE OWNER'S AUTHORIZED REPRESENTATIVE IN THE FIELD PRIOR TO INSTALLATION. OWNER'S REPRESENTATIVE RESERVES THE RIGHT TO ADJUST PLANTS TO EXACT LOCATION IN FIELD.
- 5. CONTRACTOR SHALL BE RESPONSIBLE FOR VERIFYING ALL PLANT COUNTS AND SQUARE FOOTAGES. QUANTITIES ON PLANS TAKE PRECEDENCE OVER WRITTEN QUANTITIES.
- 6. ALL DISTURBED AREAS WITHIN THE PROJECT SITE SHALL BE SCARIFIED TO A MIN. DEPTH OF EIGHT INCHES. PRIOR TO PLANTING, ALL PLANTING AREAS SHALL BE FINE GRADED AND RECEIVE SOIL PREPARATION.
- 7. FINISH GRADES OF ALL TURF AREAS SHALL BE 1" BELOW ADJACENT CURB, PAVEMENT, OR HEADER. FINISH GRADES OF ALL SHRUB AREAS SHALL BE 2" BELOW ADJACENT CURB, PAVEMENT, OR HEADER.
- 8. DO NOT MAKE SUBSTITUTIONS. IF SPECIFIED LANDSCAPE MATERIAL IS NOT OBTAINABLE, SUBMIT PROPOSAL FOR USE OF EQUIVALENT MATERIAL TO THE LANDSCAPE ARCHITECT FOR FINAL APPROVAL.

- 9. PROVIDE A 2" LAYER OF SHREDDED HEMLOCK BARK TO ALL PLANTING AREAS AND DISTURBED AREAS THAT ARE NOT DESIGNATED AS TURF.
- 10. APPLY A PRE-EMERGENT HERBICIDE TO ALL PLANTING AREAS ONCE PRIOR TO INSTALLATION OF MULCH AND ONCE AFTER. NO PRE-EMERGENT SHALL BE USED IN SEEDED AREAS.
- 11. CONTRACTOR SHALL CONDUCT AGRICULTURAL SUITABILITY AND FERTILITY SOILS TESTING. ANALYSIS SHALL INCLUDE RECOMMENDATIONS FOR SOIL PREPARATION AND BACKFILL MIX AS WELL AS RECOMMENDATIONS FOR POST MAINTENANCE FERTILIZATION. SUBMIT SOILS ANALYSIS TO OWNER'S AUTHORIZED REPRESENTATIVE FOR REVIEW PRIOR TO SOIL PREPARATION.
- 12. PLANT ALL TREES A MINIMUM OF 5' FROM ANY ROOF DRAIN LINES. THE LANDSCAPE CONTRACTOR MUST VERIFY THE LOCATION OF ALL DRAIN LINES PRIOR TO COMMENCING WORK.
- 13. TREES ARE TO BE A MINIMUM DISTANCE AWAY FROM CURBS AND ANY HARDSCAPE SUCH AS WALKS, PER LOCAL AGENCY STANDARDS.
- 14. THE INSTALLING CONTRACTOR WILL MAINTAIN/WARRANTEE PLANTING FOR ONE (1) YEAR STARTING FROM THE DATE OF PROJECT FINAL ACCEPTANCE. FOLLOWING THIS ONE YEAR PERIOD, ALL LANDSCAPE AND IRRIGATION WILL BE MAINTAINED BY THE OWNER.
- 15. MAINTAIN PLANTING AND PRUNING HEIGHTS WITHIN CLEAR VISION AREAS PER GOVERNING AGENCY STANDARDS.
- 16. CONTRACTOR IS RESPONSIBLE FOR REPLACEMENT OF ANY EXISTING MATERIALS THAT ARE DAMAGED DURING CONSTRUCTION.


REVISIONS

SAGE RESOURCES, INC.

Landscape Architecture P.O. Box 1311 Sisters, OR 97759 541.549.6227 Marlys Underwood, RLA -5/1

REGISTERES 602 MARLYS A LINDERWOOD E OREGON OREGON

> PLANTING PLAN

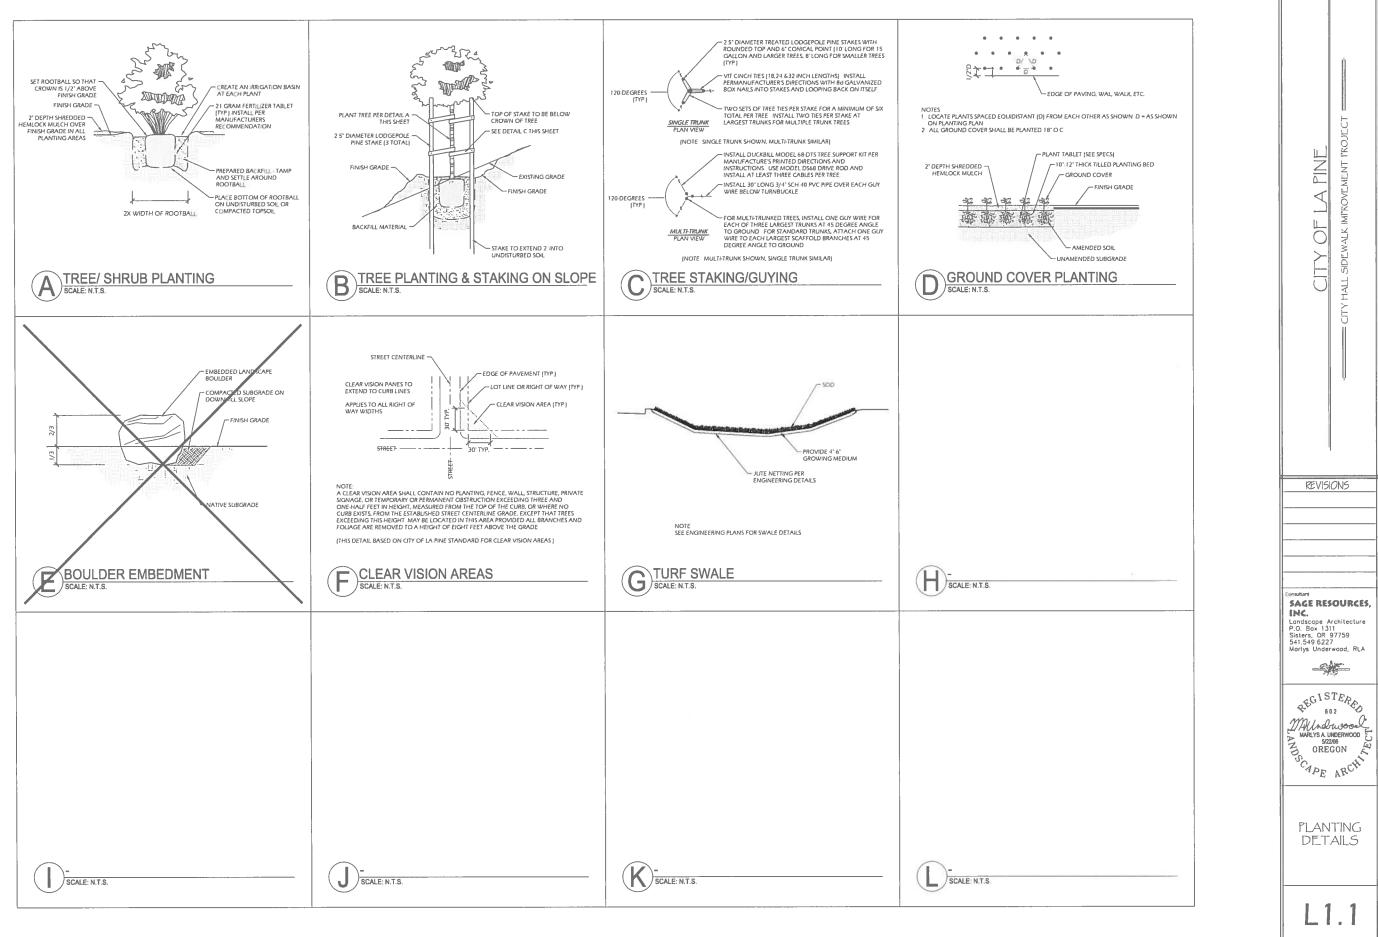

13.00009.100

11. APR. 2014

	IRRIGATION	LEGEND			
SYM	PRODUCT	MANUFACTURER	MODEL	SIZE	QTY.
	POINT OF CONNECTION	EXISTING?	-	-	1
X	6 STATION CONTROLLER	RAINBIRD OR APPROVED EQUAL	ESP MODULAR	-	1
28	REDUCED PRESSURE BACKFLOW PREVENTER	FEBCO OR APPROVED EQUAL	825Y	-	1
\bowtie	ISOLATION VALVE	FEBCO OR APPROVED EQUAL	623-BS	-	2
•	QUICK COUPLING VALVE	RAINBIRD OR APPROVED EQUAL	44-LRC	1"	3
	TURF VALVE	RAINBIRD OR APPROVED EQUAL		1.5"	2
•	DRIP CONTROL ZONE	RAINBIRD OR APPROVED EQUAL	XCZ-100-PRB-COI	M 1	2
\odot	MANUAL DRAIN VALVE	RAINBIRD OR APPROVED EQUAL	-		4
	MAINLINE	SCHEDULE 40 PVC	-	VARIES	-
	LATERALS	CLASS 200 PVC	-	VARIES	-
	LANDSCAPE DRIPLINE	RAINBIRD OR APPROVED EQUAL	LD-09-12	-	-
==	SLEEVES	PVC CLASS 200	-	VARIES	-
VARIOUS	SPRAY HEADS	RAINBIRD OR APPROVED EQUAL	SEE HEAD KEY		

RAINBIRD

OR APPROVED EQUAL

XB-20-PC

XERI-BUG EMITTERS

2 EMITTERS AT EACH TREE

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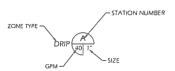
SYM	MANUFACTURER & CAT NUMBER	RADIUS	GPM
	RAINBIRD 5 SERIES MPR	5'	0.10 - 0.41
(a)	OR APPROVED EQUAL		
	RAINBIRD 8 SERIES MPR	8'	0.26 - 1.05
	OR APPROVED EQUAL		
•	RAINBIRD 10 SERIES MPR	10'	O.39 - 1.58
	OR APPROVED EQUAL		
•	RAINBIRD 12 SERIES MPR	12'	0.65 - 2.60
000	OR APPROVED EQUAL		
O	RAINBIRD 15 SERIES MPR OR APPROVED EQUAL	15'	0.92 - 3.7
NOTE:			

NOTE:

USE VAN SERIES NOZZLES WHERE REQUIRED TO PROVIDE ADEQUATE COVERAGE FOR ALL LAWN AREAS.

		OWING GPM C	PIPE SIZING, DO NOT OF WATER USAGE PER
ı	FLOW	PIPE SIZE	
1	1-12 GAL	3/4°	CLASS 200 PVC
1	12-20 GAL	17	CLASS 200 PVC
1	20-30 GAL	I 1/4°	CLASS 200 PVC
1	30-45 GAL	1 1/2"	CLASS 200 PVC
ı	45-60 GAL	2*	CLASS 200 PVC
1	60-90 GAL	2 1/2*	CLASS 200 PVC
1	90-150 GAL	3.	CLASS 200 PVC
1	150-250 GAL	4*	CLASS 200 PVC
ı	250-600 GAL	6*	CLASS 200 PVC
1			

VALVE CALL OUT



IRRIGATION NOTES

- 1. PRIOR TO COMMENCEMENT OF ANY WORK, THE CONTRACTOR SHALL VERIFY LOCATIONS AND DEPTHS OF ANY UTILITIES THAT MAY BE AFFECTED BY HIS/HER WORK, AND SHALL BE RESPONSIBLE FOR DAMAGES TO SUCH UTILITIES CAUSED AS A RESULT OF THIS WORK.
- 2. THE CONTRACTOR SHALL COMPLY WITH ALL LOCAL, STATE, AND FEDERAL LAWS, CODES, AND REGULATIONS APPLICABLE TO THE IRRIGATION SYSTEM COVERED BY THESE PLANS.
- 3. THE CONTRACTOR IS RESPONSIBLE FOR OBTAINING AND COMPLYING WITH ALL PERMITS REQUIRED TO COMPLETE THE IRRIGATION WORK COVERED BY THESE PLANS.
- 4. THE CONTRACTOR SHALL BE RESPONSIBLE FOR ALL IRRIGATION COVERAGE TO ALL PLANT MATERIAL SPECIFIED. CONTRACTOR SHALL ADJUST SPRINKLER SYSTEM TO PREVENT OVERSPRAY ONTO PAVED OR BUILT STRUCTURES.
- 5. ALL PIPE SHALL BE INSTALLED PER THE MANUFACTURER'S SPECIFICATION AND ASTM STANDARD D-2774 AT THE DEPTHS SHOWN IN THE IRRIGATION DETAILS.
- 6. FLUSHING OF ALL LINES PRIOR TO INSTALLATION OF EMISSION DEVICE IS REQUIRED.
- 7. ALL ELECTRICAL CONNECTIONS SHALL BE MADE AT THE REMOTE CONTROL VALVE BOXES, CONTROLLER ENCLOSURES AND VALVE BOXES SPECIFICALLY FOR ELECTRICAL CONNECTIONS. NO SPLICES SHALL BE MADE WITHOUT BEING IN A VALVE BOX OR ENCLOSURE.
- 8. 110 VOLT ELECTRICAL POWER OUTLET AT THE AUTOMATIC CONTROLLER LOCATION SHALL BE PROVIDED BY OTHERS. THE CONTRACTOR SHALL BE RESPONSIBLE FOR THE FINAL HOOK UP FROM THE ELECTRICAL OUTLET TO THE AUTOMATIC CONTROLLER.
- 9. ALL ELECTRICAL WORK SHALL BE INSTALLED PER LOCAL CODE.
- 10. INSTALL ALL REMOTE CONTROL VALVES AS HIGH AS POSSIBLE BUT ALLOWING CLEARANCE BETWEEN VALVE BOX LID AND FLOW CONTROL HANDLE ON REMOTE CONTROL VALVE.
- 11. ALL PVC SOLVENT WELD FITTINGS SHALL BE 'SPEARS' OR APPROVED EQUAL.
- 12. PROVIDE TWO (2) SPARE WIRES ALONG THE ENTIRE LENGTH OF MAINLINE AND LOOPED INTO EACH ELECTRIC REMOTE CONTROL VALVE BOX.
- 13. THE CONTRACTOR SHALL BE RESPONSIBLE FOR SUPPLYING ALL NECESSARY EQUIPMENT. INCLUDING BUT NOT LIMITED TO ALL WIRING AND ALL LABOR REQUIRED TO PROVIDE A COMPLETE FUNCTIONING CONTROL SYSTEM AS DETAILED ON THE PROJECT PLANS.
- 14. THE REDUCED PRESSURE ASSEMBLY SHALL BE ENCLOSED WITH A "GUARD SHACK" **ENCLOSURE OR APPROVED EQUAL.**
- 15. TREES, SHRUBS AND TURF SHALL BE ON SEPARATE REMOTE CONTROL VALVES.
- 16. ALL SLEEVES ARE TO HAVE A PULL BOX LOCATED AT EACH END.
- 17. ALL VALVES, CLEAN-OUT, METERS, AND BOXES (INCLUDING IRRIGATION) SHALL BE ADJUSTED TO FINISH GRADE AND SHALL BE INCIDENTAL TO CONSTRUCTION WORK.

REVISIONS

SAGE RESOURCES. INC.


Landscape Architecture P.O. Box 1311 Sisters, OR 97759 541.549.6227 Marlys Underwood, RLA

REGISTERES 602 MARLYS A. UNDERWOOD E OCAPE ARCHI

> IRRIGATION PLAN

13.00009.100

II. APR. 2014

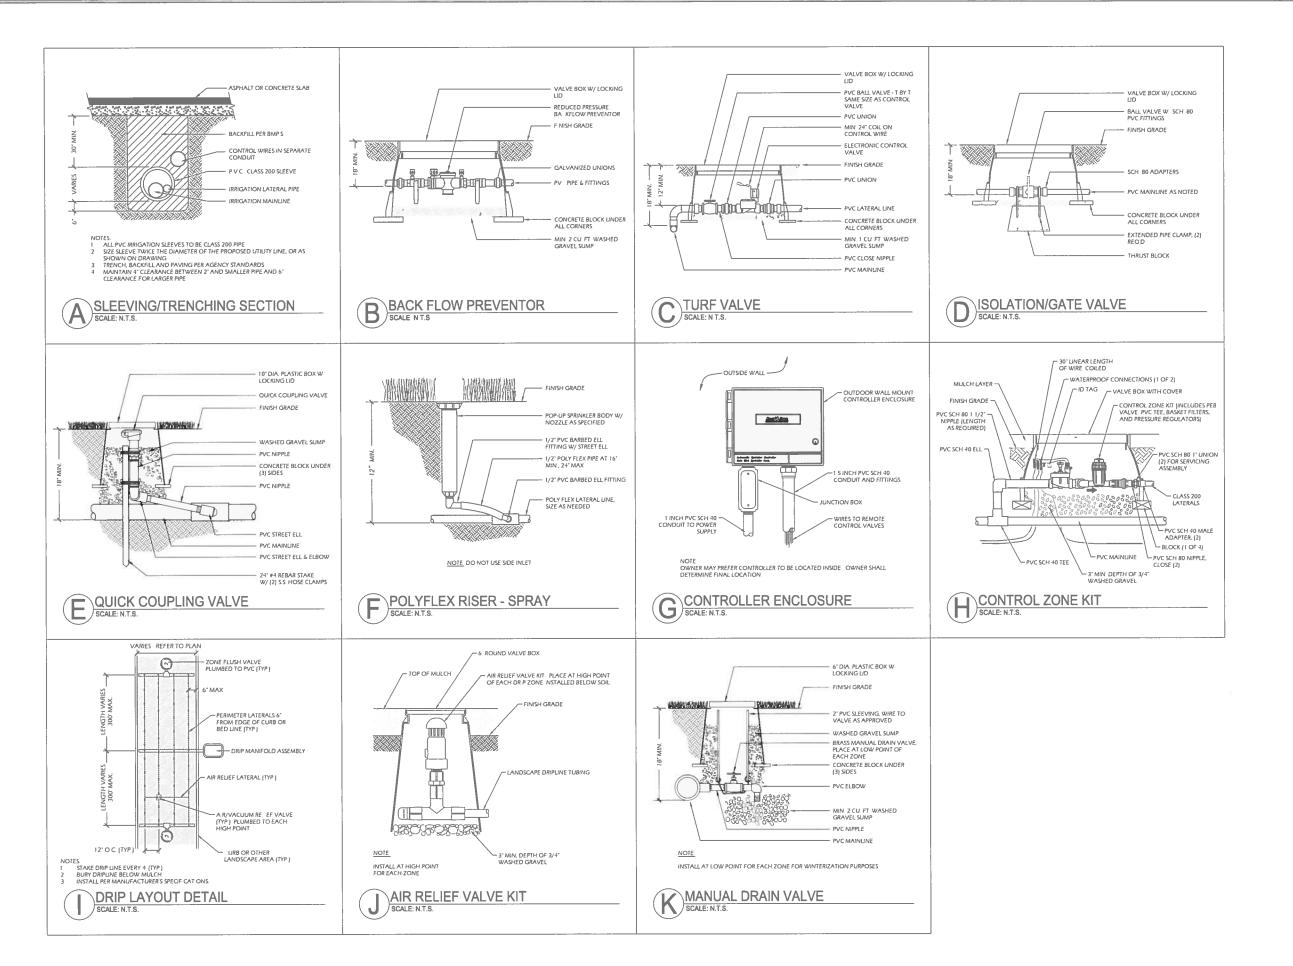

CITY OF LA PINE

REVISIONS

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SAGE RESOURCES, INC. Landscope Architecture P.O. Box 1311 Sisters, OR 97759 541 549 6227 Marlys Underwood, RLA





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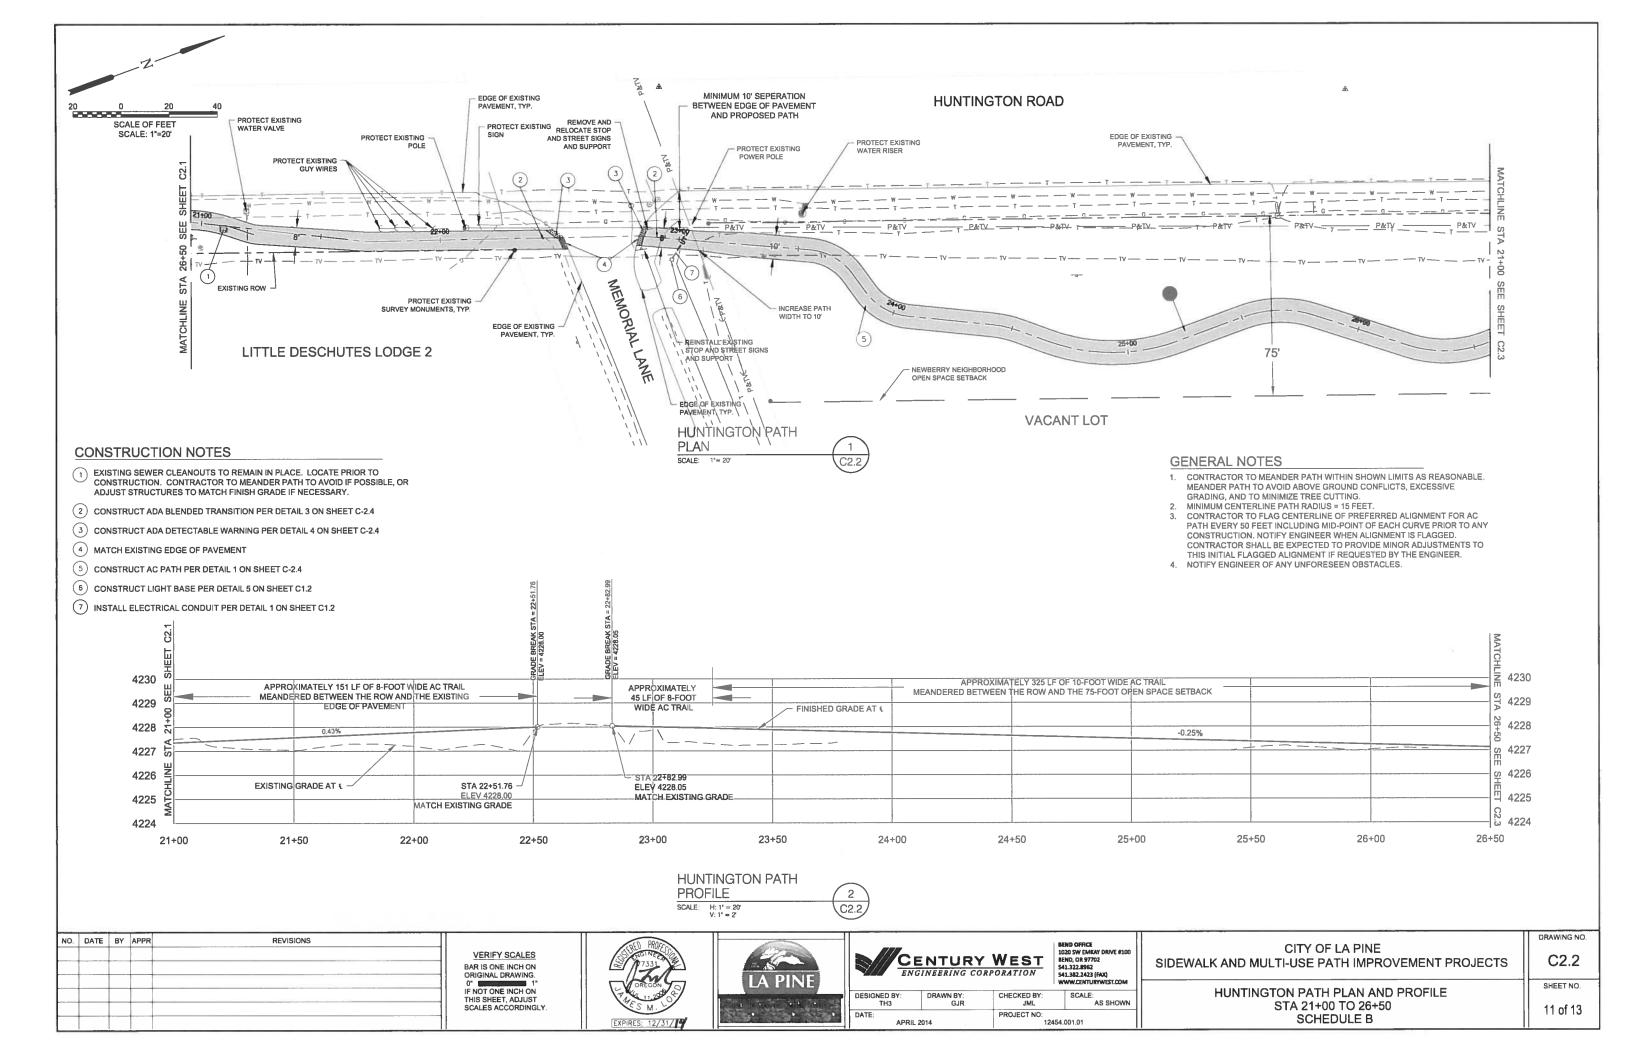
IRRIGATION DETAILS


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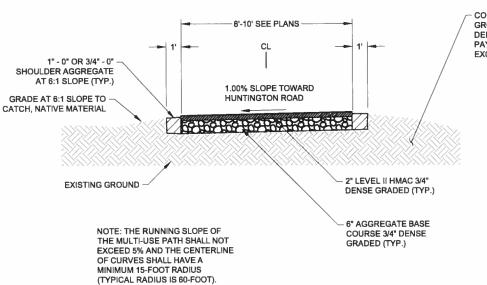
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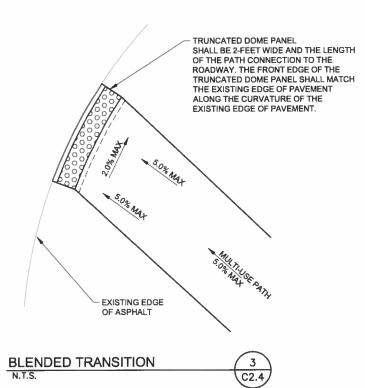


MULTI-USE PATH TYPICAL SECTION

CONTRACTOR TO MATCH EXISTING GROUND AS MUCH AS POSSIBLE WITHIN DEFINED LIMITS. NO ADDITIONAL PAYMENT WILL BE MADE FOR EXCAVATION OR EMBANKMENT WORK.

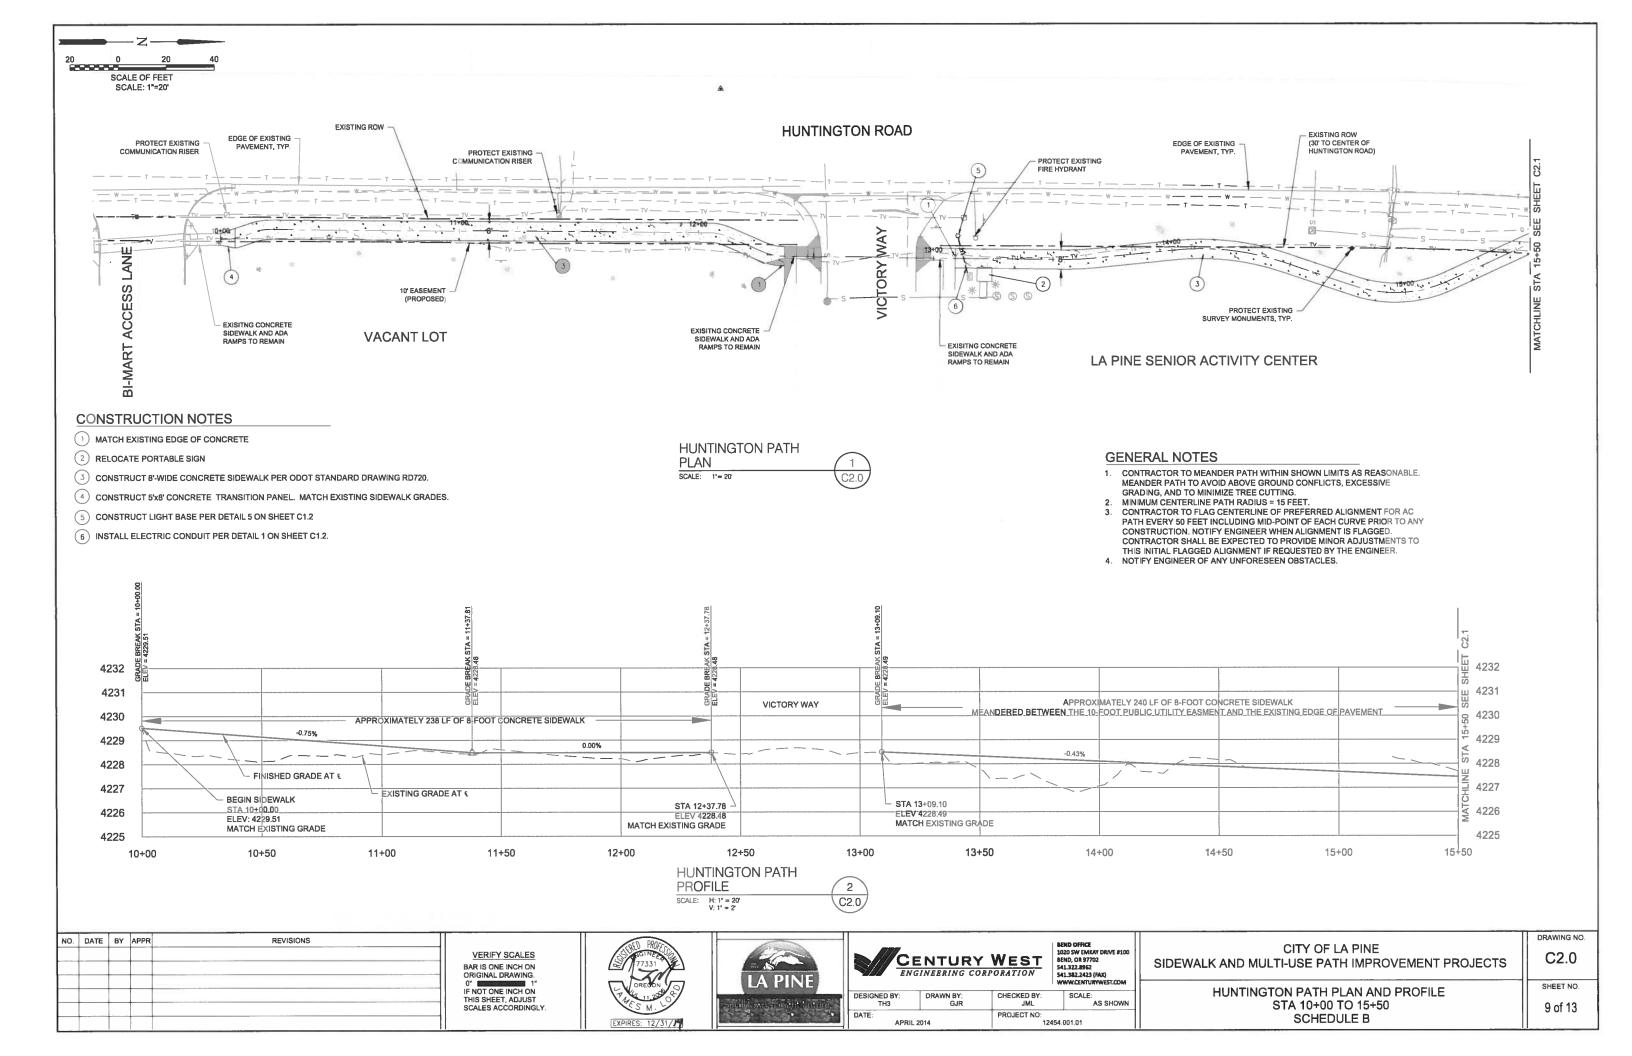CONTRACTOR SHALL REMOVE BRANCHES OR OTHER OBSTRUCTIONS WHICH PENETRATE OR MAY POTENTIALLY PENETRATE THIS CLEAR ZONE AS DETERMINED BY THE OWNER BRANCHES SHALL BE REMOVED TO THE TRUNK OF THE TREE. -VARIES FINISHED PATH SURFACE

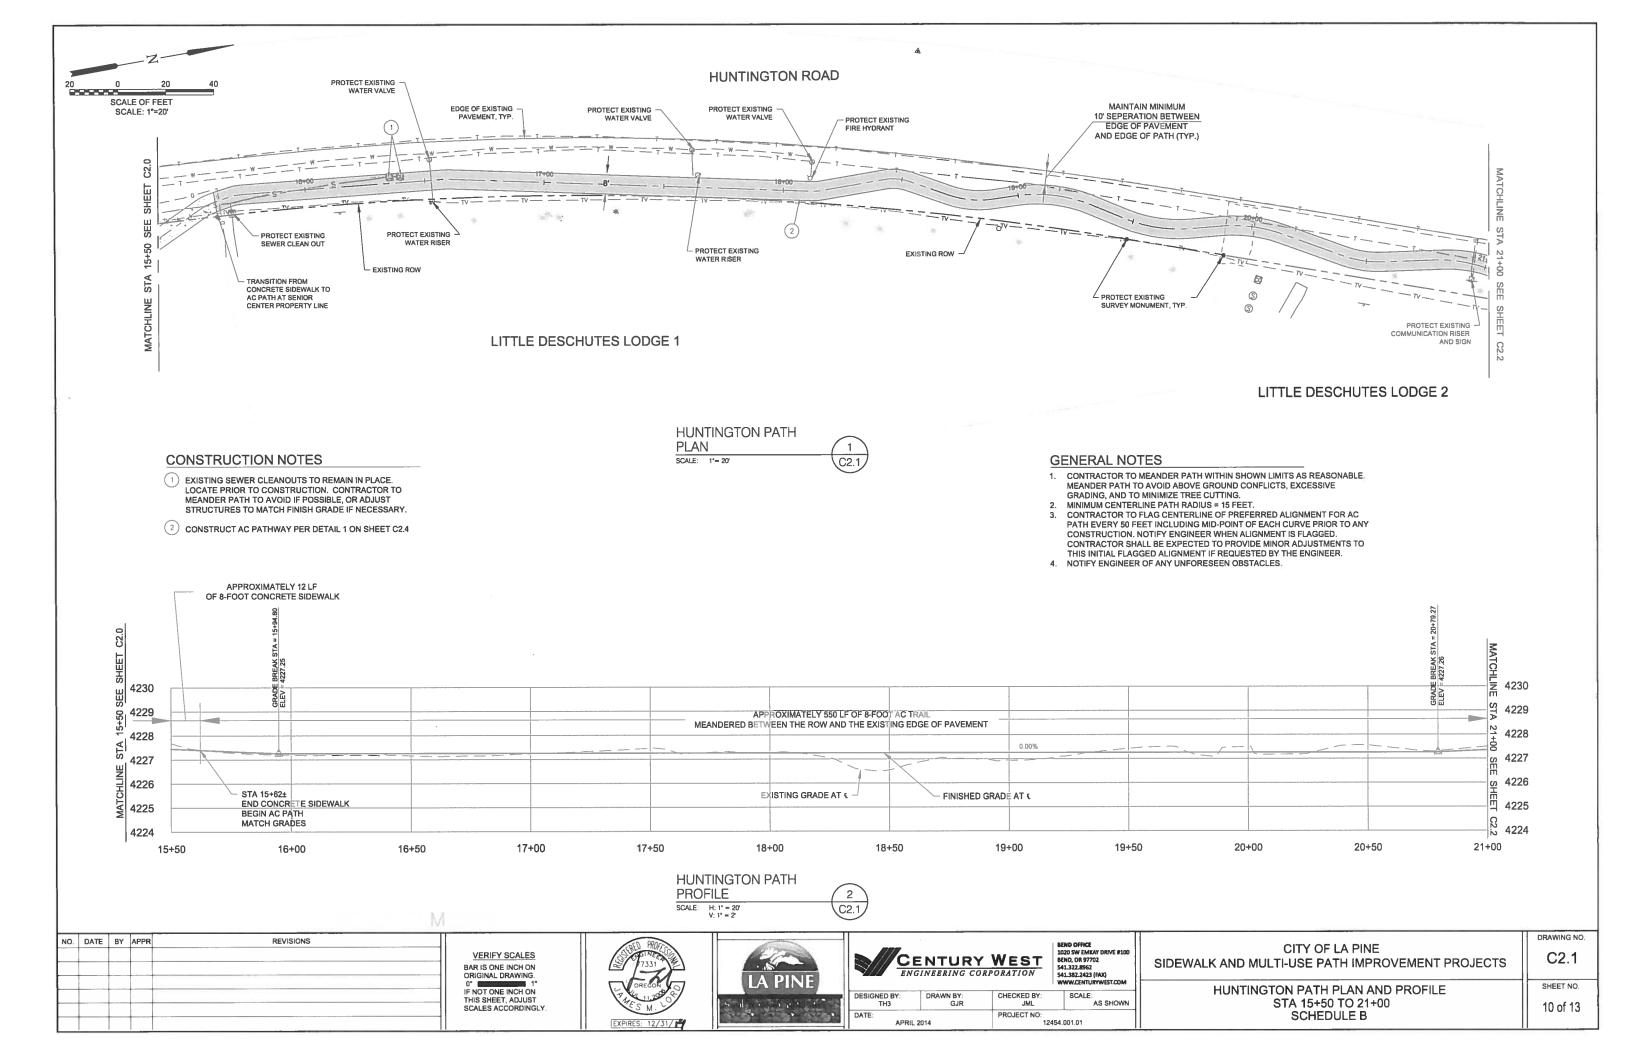PATH CLEAR ZONE

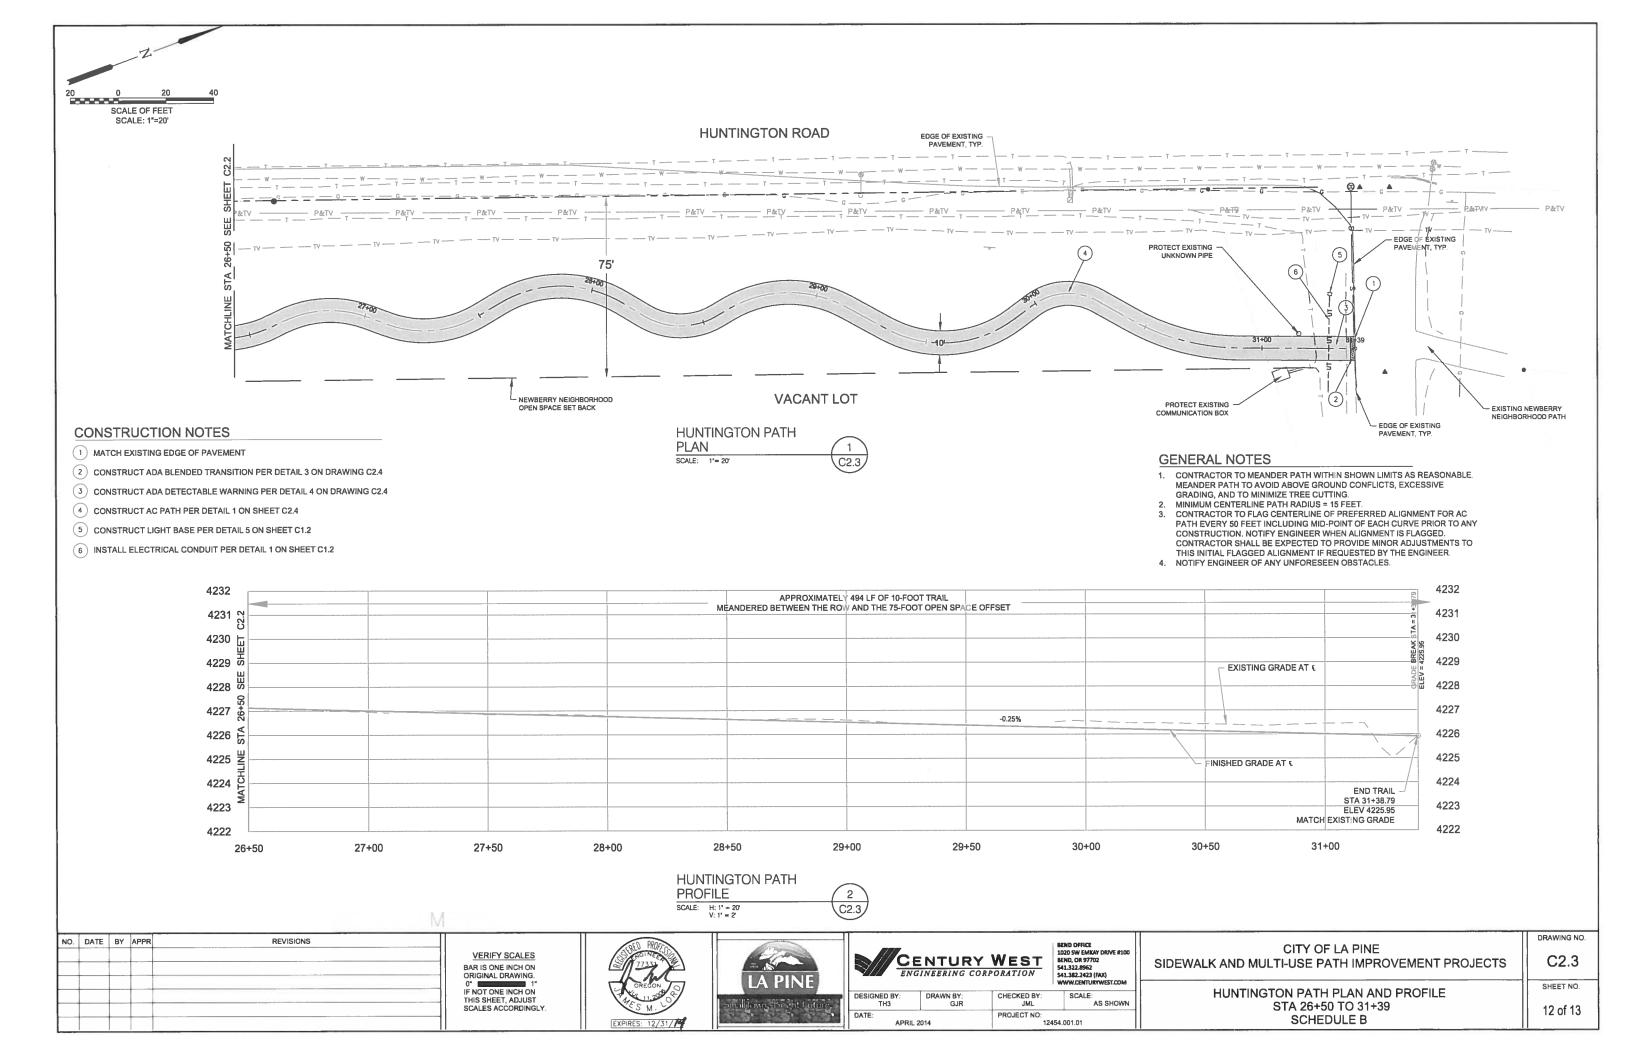

EXISTING EDGE OF PAVEMENT

CONSTRUCT RADIAL DETECTABLE WARNING: SAWCUT AND REMOVE ASPHALT AND CONSTRUCT CONCRETE PAD FOR DETECTABLE WARNING PANEL. CONCRETE PAD SHALL BE A MINIMUM 3-FOOT WIDTH. CONTRACTOR SHALL CUT DETECTABLE
WARNING PANELS PER MANUFACTURER
RECOMMENDATIONS TO BEST FIT PANEL ALONG THE CURVATURE OF THE EDGE OF


DETECTABLE WARNING

BID DOCUMENTS

NO.	DATE	BY	APPR	REVISIONS

VERIFY SCALES BAR IS ONE INCH ON ORIGINAL DRAWING.

0" 1" 1" IF NOT ONE INCH ON THIS SHEET, ADJUST SCALES ACCORDINGLY

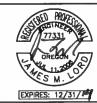



CENTURY WEST

	ENTURY	BEND OFFICE 1020 SW EMKAY DRIVE #100 BEND, OR 97702 541.322.8962 541.382.2423 (FAX) WWW.CENTURYWEST.COM		
SIGNED BY: DRAWN BY: CHECKED BY: SCALE: TH3 JML SCALE:		SCALE: AS SHOWN		
TE:	2014	PROJECT NO:	54 001 01	

CITY OF LA PINE SIDEWALK AND MULTI-USE PATH IMPROVEMENT PROJECT	C2.4
HUNTINGTON PATH GENERAL CONSTRUCTION DETAILS	SHEET NO.

SCHEDULE B

13 of 13